

07-22-2022


ROBERTS CIVIL ENGINEERING
301 SEA ISLAND ROAD, SUITE 10
ST. SIMONS, GA 31522
912-638-9681 OFFICE
912-614-5689 FAX

PREPARED FOR:
TRAVIS WEBB




DOCK SITE PLAN
116 BURNETT ROAD
BRUNSWICK, GA

DATE: 2022-03-02
PROJECT NO.: 21095
DRAWN BY: CS
CHECKED BY: SW
SCALE: 1" = 30'

1

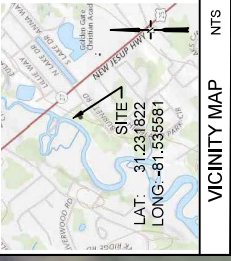

VICINITY MAP
NTS

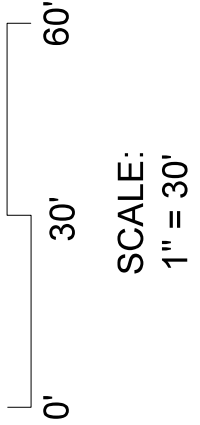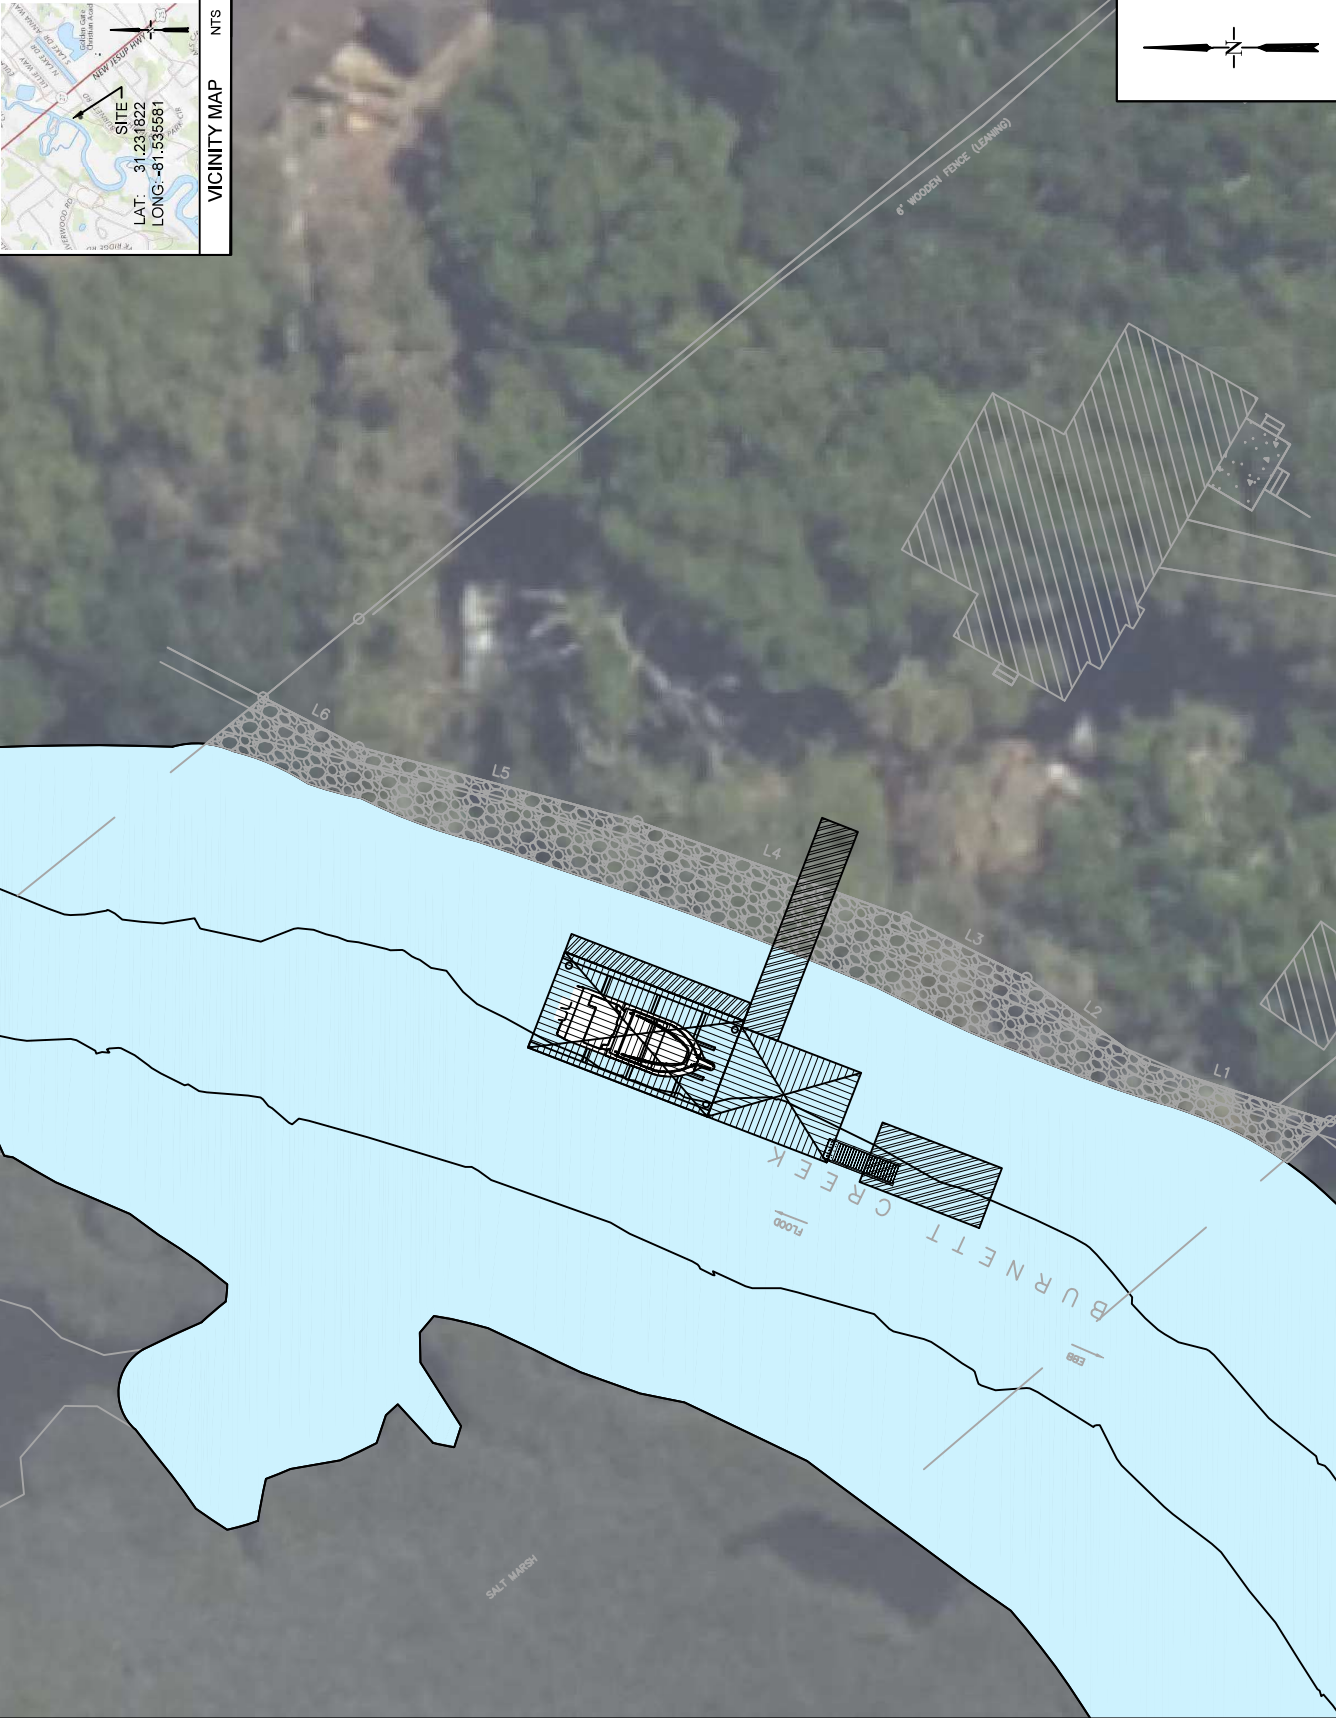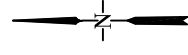

- NOTES:
1. THE DOCK PLANS SHOWN HEREIN SHALL BE USED ONLY AS AN EXHIBIT FOR DOCK PERMITTING WITH THE GEORGIA DEPARTMENT OF NATURAL RESOURCES.
 2. DEPTHS OF THE CHANNEL WERE OBSERVED BY SHUPE SURVEYING COMPANY, PC.
 3. MEAN LOW WATER LINE ELEVATION IS BASED ON NGS TIDAL BENCHMARK BR0079 (STA8677344) ST. SIMONS ISLAND LIGHTHOUSE.





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PREPARED FOR:
 TRAVIS WEBB

PROPOSED DOCK PLAN
 116 BURNETT ROAD
 BRUNSWICK, GA

DATE: 2022-03-02
 PROJECT NO.: 21095
 DRAWN BY: CS
 CHECKED BY: SW
 SCALE: 1" = 30'

3

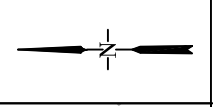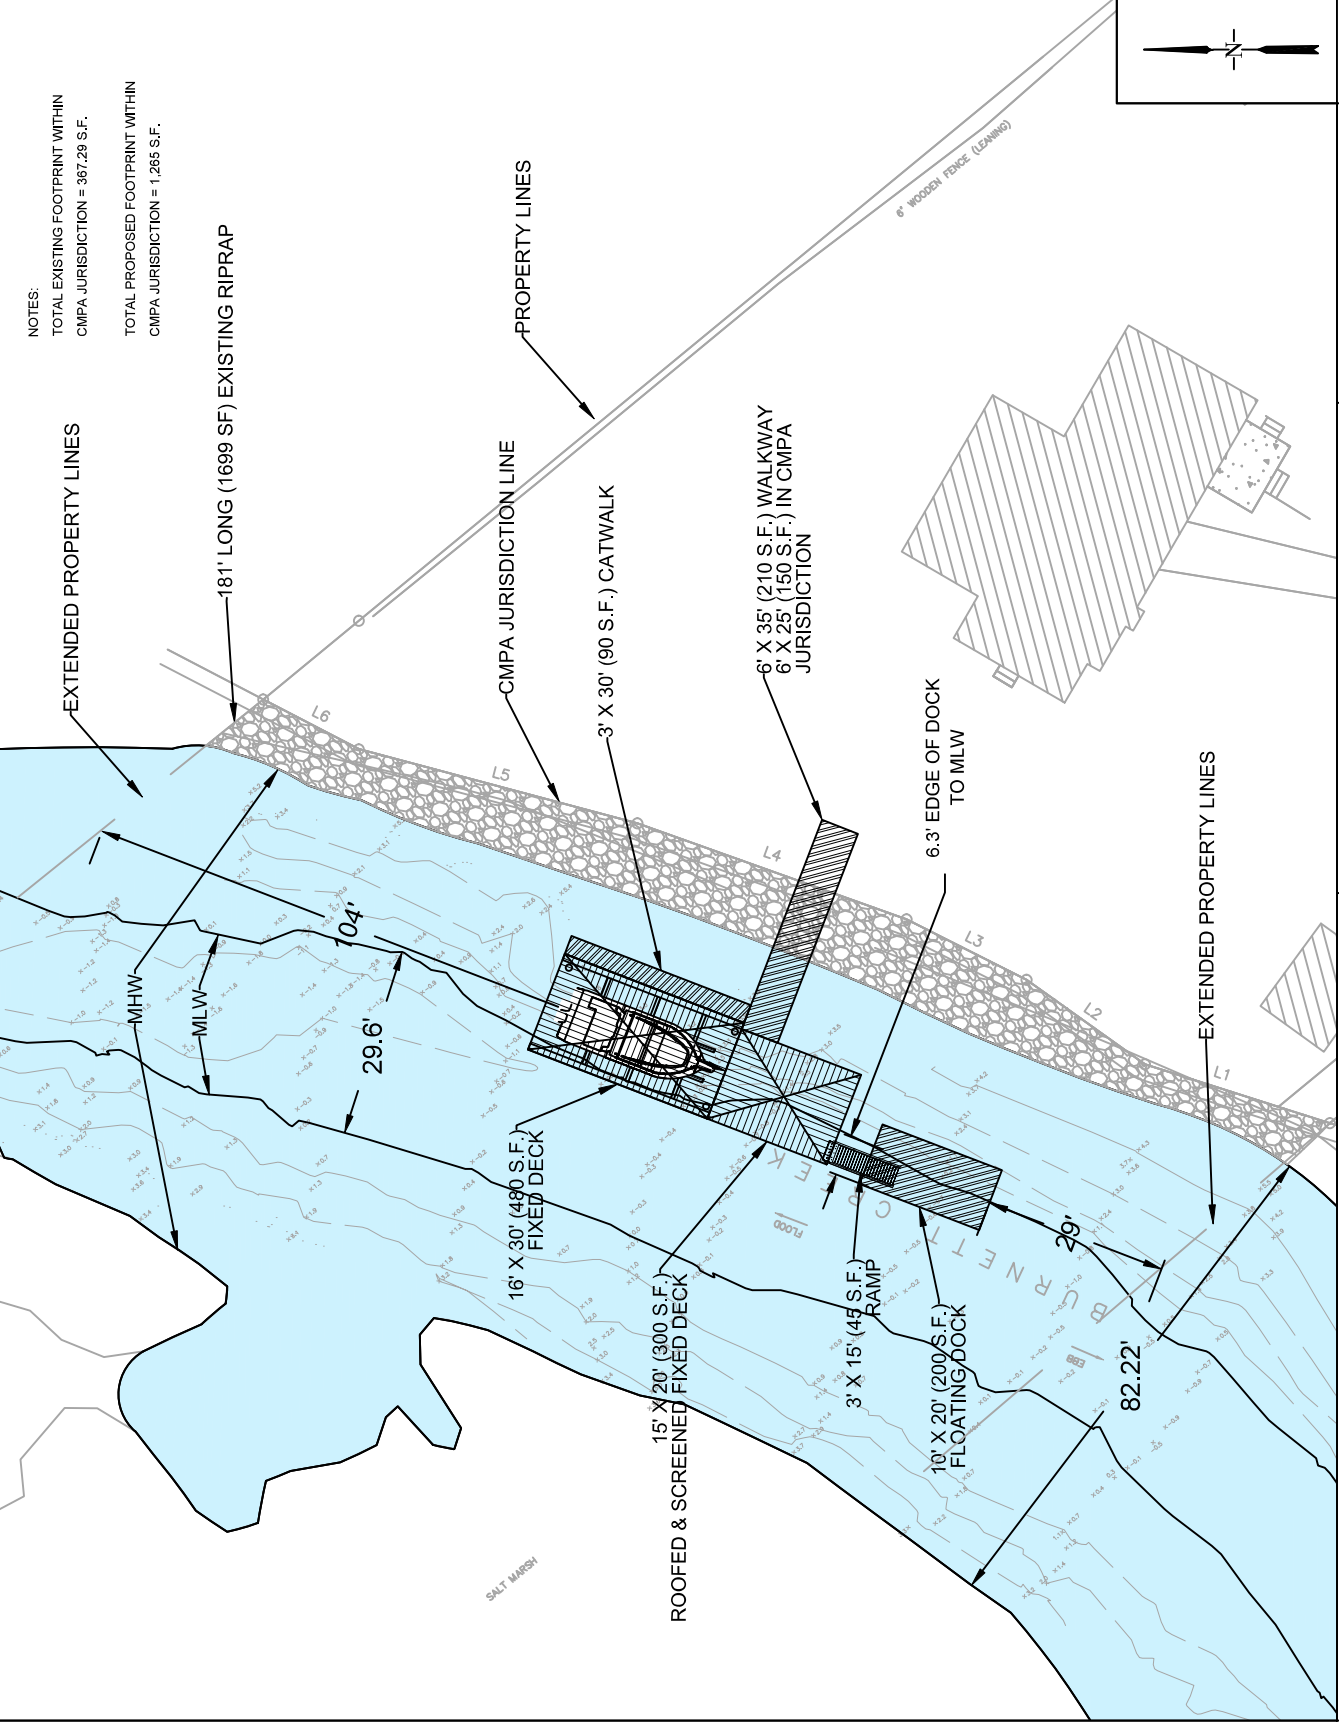

NOTES:

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